

PART 8 PLANNING APPLICATION



FOR 1 No. 4 BED SINGLE STOREY DWELLING AT CLOONAHARD, Co. LONGFORD





Client:

Longford County Council, Town Hall, Market Square, Longford, Co. Longford.

Tel: 043 3343300

Originator:

Longford County Council, Town Hall, Market Square, Longford, Co. Longford.

Tel: 043 334330

PART 8 PLANNING PROPOSAL FOR:

Construct 1 No. 4 Bed Single Storey Dwelling at Cloonahard, Co. Longford

Contents:

- 1. Site Notice
- 2. Newspaper Notice
- 3. Project Description
- 4. Site Characterisation Report
- 5. Site Location
- 6. Existing Site Layout
- 7. Proposed Site Layout & Site Services
- 8. Floor Plan and Elevations
- 9. Elevations and Section A A



Longford County Council

SITE NOTICE

Planning and Development Acts 2000-2018

Part 8 Planning and Development Regulations 2001-2015

Notice of Proposed Development

19th July 2019

Construct 1 No. 4 Bed Single Storey Dwelling at Cloonahard, Co. Longford

Notice is hereby given that in accordance with the requirements of the above regulations that Longford County Council proposes to undertake the following works:

The development will consist of the demolition of existing dwelling and associated outbuildings, provision of 1 No. single storey 4 bedroom dwelling including proprietary waste water treatment system, storage shed, entrance, boundary walls and associated site works.

Plans and particulars of the proposed development will be available for inspection or purchase at a fee, not exceeding the reasonable cost of making a copy, at the offices of Longford County Council, Áras an Chontae, Great Water Street, Longford. during official public opening hours, excluding weekends and bank holidays, from Friday 19th July 2019 up to and including Monday 2nd September 2019.

Submissions with respect to the proposed development, dealing with the proper planning and sustainable development of the area, may be made in writing to Longford County Council, headed "Cloonahard, Co. Longford" and addressed to *Planning Section, Longford County Council, Áras an Chontae, Great Water Street, Longford* to arrive not later than 4pm on Monday 16th September 2019.

Signed

John Brannigan Director of Services Longford Co. Council



Call 063 214531/545

of Control Graphic

Of Con

Public Notices

SETTING A LOCAL ADJUSTMENT FACTOR NOTICE OF CONSIDERATION OF

The Finance (Local Property Tax) Act 2012 (as amended), makes specific provision that elected members of a local authority may pass a formal resolution to vary the basic rate of the Local Property Tax for their administrative area by a percentage known as the local adjustment factor. At the meeting set by Longford Co. Council to consider this matter, the members may set a local adjustment factor within the range of +/- 15% of the basic rate, or, may decide not to adjust the basic rate.

ongford County Council will meet in September 2019 to consider the setting of a local

Longford County Council welcomes written submissions from the public on this matter specifically covering the potential effects of varying the basic rate of the Local Property Tax on businesses, individuals and on local authority services. Submissions must be received by Friday 16th August 2019 and be sent to:

LPT Public Consultation

Finance Department,
Longford County Council,
Aras and Chontae,

Gt. Water St., Longford

ult@longfordcoco

Longford County Council
Planning and Development Acts 2000-2014
Part 8 Planning and Development Regulations 2001-2013
Notice of proposed development

Notice is hereby given that in accordance with the requirements of the above regulations that Longford County Council proposes to undertake the following works:

Construct 1 No. 4 Bed Single Storey Dwelling at Cloonahard, Co. Longford

The development will consist of the demolition of existing dwelling and associated outbuildings, provision of 1 No. single storey 4 bedroom dwelling including proprietary waste water treatment system, storage shed, entrance, boundary walls and associated site works.

Plans and particulars of the proposed development will be available for inspection or purchase at a fee, not exceeding the reasonable cost of making a copy, at the offices of Longford County Council, Áras an Chontae, Great Water Street, Longford. during official public opening hours, excluding weekends and bank holidays, from Friday 19th July 2019 up to and including Monday 2nd September 2019.

ibmissions with respect to the proposed development, dealing with the proper

and sustainable development of the area, may be made in writing to Longford County Council, headed "Cloonahard, Co. Longford" and addressed to Planning Section, Longford County Council, Áras an Chontae, Great Water Street, Longford to arrive not later than 4pm on Monday 16th September 2019.

John Brannigan
Director of Services
Longford Co. Council

Longford County Council Aras an Chontae, Great Water Street, Longford. N39 NH56

7/



OOKING

O

CHANGE

YOUR CAR

Check out our motor section

Longford Leader

NING NOTICES

LONGFORD COUNTY
COUNCIL

We, Ballykenny Solar Ltd. wish to apply for a planning permission for the following:

A 25 year permission for a solar farm up to 19Ha with an export capacity of approximately 9MW comprising of photovoltaic panels on ground mounted steel frames, a single storey DNO building, customer room, control building, storage container, HV Kiosk, switch gear housing and 6 no. inverter transformer enclosures, ducting and electrical cabling, perimeter fencing, mounted CCTV cameras, new internal access tracks and associated drainage infrastructure and all associated vite works at, Ballyken ny, Co. Longford Please Note: This site is adjacent to the existing ESB Richmond Electricity

ird Construction Of A Resiric dential Development Of dential Development Of A No. Dwelling Houses by Consisting Of 4 No. Two Education of Type Dwelling Houses, Type Dwelling Houses, Two Storey Semi-Dedicated Type Dwelling Houses, Continuation Of Existing Internal Access Road & Public Foothe Existing Internal Access Road & Public Foothe Existing Internal Access Road & Concurently Service The Existing Estate Existing Internal Estate as Known As "Cnoc Na Greine", Entrances, Boundary Fences/Walls, Boundary Foothe Water & Water-Imain Networks And All Ancillary Works At Ancillary Works At Conc Na Greine, Carling Tagh, Granard, Cong Longford For Faughnan ic Construction.

The planning application may be inspected, or purchased at a fee not exceeding the reasonable cost of making a copy, at the offices of the planning authority during its public opening hours. A submission or observation in relation to

PUBLIC

notice to the EPA that they

intend to apply

A Natura Impact Statement will be submitted to the planning authority with the planning application. The Natura Impact Statement will be available for inspection or purchase at a fee not exceeding the reasonable cost of making a copy, during office hours at the offices of the Planning Authority.

Paddy Mahon, Chief Executive. Dated: 10th July, 2019.

A submission or observation in relation to the
application may be made
in writing to the planming authority on payment of the prescribed
fee, £20, within the period of 5 weeks beginning
on the date of receipt by
the authority of the
application, and such
submissions or observations will be considered
by the planning authority in making a decision
on the application. The
planning authority may
grant permission subject

Tony Mc Manus
T&R Designs
Consulting Engineers
Mobile: (086) 3822717

Co. Longford.

will be based

3

location which operate at a for a licence to

V Carrickboy, Co. Long- T ford

The planning application is a may be inspected or purchased at a fee not chased authority during its public opening the planning authority on a planning authority on payment of the prescribed fee of £20.00 within the period of 5 weeks beginning on the fee date of receipt by the authority of the application or observation will be considered by the planning authority in the planning authority may grant of making a decision on the sy application. The planning authority may grant on may refuse to grant performance to grant performance in mission.

a I, Joe Mc Manus intend to apply for Outline e to apply for Outline

Che development will a consist of Outline per- Insistion to erect a dwell- Inghouse and garage, I complete with proprietary effluent treatment system, including apgrade of the existing public road, including all associated site works, as

PUBLIC NOTICES

The Planning Application may be inspected or purchased at a fee not exceeding the reasonable cost of making a copy, at the offices of the Planning Authority during its public opening nours and that a submission or observation in relation to the application may be made to the authority in writing on arment of the pre-

waste recycle company, issue

ON OUR JOBS PAGE

Technologies, a

Ugiagbe Eugene Signed:

ING NOTICES

LONGFORD COUNTY
COUNCIL

LONGFORD COUNTY
COUNCIL

ING NOTICES

LONGFORD COUNTY
COUNCIL LONGFORD COUNTY
COUNCIL

We, Irish Forestry Union II

Trust (IForUT) intend to s

r apply for Permission for I

r a forest entrance onto a

public road including all (

s- I Ivan Morton wish to
fff apply to Longord Co
n- Council for Permission
d to construct a storey and
it half type dwelling
Yf house, detached garage
ess for domestic use, sewage
to treatment system with
to percolation area and
d attached ancillary site
s, works at Ballinrooey
m Dring Co Longford.
e- The planning application
to may be inspected or

n Full Planning Permis
o sion Is Being Sought Off si
r Longford County Couna cil For The Proposed ci
ll Change Of Use Of Part Ci
te Of The Former Atlantic
d Mills Factory From A
... Manufacturing Facility C
- To A Recycling Facility T
To Include Processing, S
m Recycling & Recovery I
To Include Processing, S
m Recycling & Recovery I
To Of The Following; 2
ot Wood, Plastic, Card- I
a- board, Paper & Metal, tr
a Consent will be Applied I
a Consent will be Applied I
a Consent will be Applica B
tion, Under A Waste
For Under A Waste
For Under The Waste
or Management (Facility S
or Darreit and Registration) I

lanagement (Facility Semit and Registration) Regulations 2007 – as Kegulations 2007 – as Kegulation Seminended. Full Planning Cermission Is Also Eernission Is Also Eernission Is Also Eernission Is Also Eernission For The Cooms Together With Inchestions To The Axisting Rear And Side Cacades Of The Existing Former Factory Building Inches As "Atlantic Childs" And All Associtied Ancillary Works At it ishersitown, Cloondara, pool Longford For Wood Existing Former Factory Building Inches Associated Ancillary Works At it ishersitown, Cloondara, pool Longford For Wood Existence Inches Inches

the application may be made in writing to the planning authority on payment of the prel scribed fee, £20, within the period of 5 weeks beginning on the date of receipt by the authority of the application, and such submissions or observations will be constrained by the planning authority in making a decision on the application. The planning

uthority may grant per nission subject to o without conditions, o may refuse to grant per

gned: Ivan Morton

BREAKING

NEWS

a Signed:
S Collins Boyd Engineering Ltd.
Engineers & Architects

COUNCIL

Cunningham Design

& Planning Limited

Block C,

N4 Axis Centre,

Longford, Co. Longford

Axis Centre, ngford, Co. Longford

writing on payment of the prescribed fee, within the period of 5 weeks beginning on the date of receipt by the authority of the application. gham Design ning Limited Contact **043 33 45241**

Longford Leader



POTENTIAL APPLICANTS
WITH A PRINT ADVERT REACH OVER 20,404

For more details contact 043 33 45241

ongford Leader

www.longfordleader.ie



Longford County Council

PROPOSED DEVELOPMENT CONSISTING OF DEMOLISHION OF EXISTING DWELLING AND CONSTRUCTION OF 1 No. 4 BED SINGLE STOREY DWELLING AT CLOONAHARD, Co. LONGFORD.

PROJECT DESCRIPTION

General

The site is a rural site (of 0.413ha) located in the townland of Cloonahard, just off the main N4 road network between Longford Town and Edgeworthstown (on the L1092). It is located approximately 4 kilometres from Ardagh Village where local services, schools and convenience shopping can be accessed. It is also approximately 7 kilometres from Longford Town where additional local services, schools and convenience shopping is available.

It is proposed to demolish the existing dwelling including various extensions, which are in a dilapidated & substandard condition (and located close to the main road). The existing out buildings on the site will also be demolished, enabling the proposed front boundary wall and dwelling to be set back from the existing road to align with the adjoining dwelling. This will also improve vehicular access to the site and facilitate possible future road widening.

There is existing ESB overhead lines at the rear of the existing dwelling that will be diverted to an underground duct as part of the works.

Design

It is proposed to construct a high quality 4 bed (7-person) single storey house of 124m² with a driveway and on-site parking to the front of the house. There will a front and rear garden space to suit the location and character of the adjoining dwellings.

Services

All existing main services such as water, storm, Eircom and electricity are available along the existing roads. A new wastewater treatment system will be installed on site.

SITE CHARACTERISATION FORM

File Reference:
1.0 GENERAL DETAILS (From planning application)
Prefix: Mr. First Name: Mary Surname: Clarke
Address: C/o Cunningham Design & Planning Block C, N4 Axis Centre, Longford, Co. Longford Site Location and Townland: Cloonahard, Longford, Co. Longford
Telephone No: 043-3340450 Fax No: N/A
E-Mail: mark@cunninghamdp.ie
Maximum no. of Residents: 6 No. of Double Bedrooms: 4 No. of Single Bedrooms: 0
Proposed Water Supply: Mains 🗸 Private Well/Borehole Group Well/Borehole
2.0 GENERAL DETAILS (From planning application)
Soil Type, (Specify Type): AminDW - Deep well drained mineral (Mainly acidic)
Aquifer Category: Regionally Important Locally Important U Poor Poor
Vulnerability: Extreme High ✓ Moderate Low High to Low Unknown
Bedrock Type: Lucan Formation
Name of Public/Group Scheme Water Supply within 1 km: Longford County Council
Groundwater Protection Scheme (Y/N): Yes Source Protection Area: SI SO
Groundwater Protection Response: R1
Presence of Significant Sites (Archaeological, Natural & Historical):
Past experience in the area: None
Comments: (Integrate the Information above in order to comment on: the potential suitability of the site, potential targets at risk, and/or any potential site restrictions).
The site may be suitable. Surface water and ground water as a resource are potential targets at risk. R1 Acceptable subject to normal good practice (i.e. system selection, construction, operation and maintenance in accordance with CoP)

Note: Only information available at the desk study stage should be used in this section.

3.0 ON-SITE ASSESSMENT

3.1 Visual Assessment									
Landscape Position: Level									
Slope: Steep (>1:5) Shallow (1:5-1:20) Relatively Flat (<1:20)									
Surface Features within a minimum of 250m (Distance To Features Should Be Noted In Metres)									
Houses: Houses in close proximity to the proposed site, see enclosed Ordnance Survey Map.									
Existing Land Use: Existing site for existing dwelling house									
Vegetation Indicators: Grass on site									
Groundwater Flow Direction: West									
Ground Condition: Ground dry and firm underfoot									
Site Boundaries: Existing whitethorn hedgerows Roads: Site is accessed from adjoining entrance									
Outcrops (Bedrock And/Or Subsoil): None within 250m									
Outorops (Bedrook Allaron Gabson).	_								
Surface Water Ponding: None within 250m Lakes: None within 2km									
Beaches/Shellfish: None within 250m Areas/Wetlands: None within 250m	7								
	_								
Karst Features: None within 250m Watercourse/Stream*: None within 250m									
Drainage Ditches*: Along South Western Boundary Springs / Wells*: None within 250m									
Comments: (Integrate the Information above in order to comment on: the potential suitability of the site, potential targets at risk, the suitability of the site to treat the wastewater and the location of the proposed system within the site).									
The potential targets at risk are ground and surface water. The vegetation on site together with the large amount of surface water features in close proximity of the site such as the drainage ditches indicates poor permeability and a high water table level and therefore there is a potential for an hydraulic issue onsite. There are no site restrictions. The site maybe suitable for development.									

^{*}Note and record water level

3.2 Trial Hole (should be a minimum of 2.1m deep (3m for regionally important aquifers))

To avoid any accidental damage, a trial hole assessment or percolation tests should not be undertaken in areas, which are at or adjacent to significant sites (e.g. NHAs, SACs, SPAs, and/or Archaeological etc.), without prior advice from National Parks and Wildlife Service or the Heritage Service.

Depth of trial hole (m): 2.10									
Depth from ground surface to bedrock (m) (if present): Depth from ground surface to water table (m) (if present): Depth from ground surface to water table (m) (if present):									
Depth of water ingress:	/pe (if present): Luc	can Formation							
Date and time of excavation: 24/04/2019	8:36 Date ar	nd time of examinat	ion: 26/04/2019	9 09:41					
Depth Soil/Subsoil Plasticity and of P/T Texture & dilatancy*** Test* Classification**	d Soil Structure	Density/ Compactness	Colour****	Preferential flowpaths					
0.1 m Horizon A = CLAY 8,7,7 Threads Ribbons 115, 117, 145. No Dilatancy		Very Soft	Dark brown	Abundant Grass Roots					
0.4 m P Horizon B = SiLT/CLAY Signal	15 Massive	Firm	Greyish Brown	Occasional Roots					
0.4 m SILT/CLAY Ribbons 95,105,11	Massive Massive	Stiff		None					
2.5 m									

There was no water table level or mottling evident anywhere in the trial hole. A SILT/CLAY layer exists at the invert level of the T Test Holes. Therefore according to Table C.3 the T value should be in a range of 15-43mins/25mm as stated in TABLE C3 of CoP. Similarly from TABLE C3 the P Value should range between 15-43mins/25mm. The potential targets at risk are ground and surface water. The site maybe acceptable for an on-site sewerage treatment system.

Likely T value: 60.00

Note: *Depth of percolation test holes should be indicated on log above. (Enter P or T at depts as appropriate).


^{**} See Appendix E for BS 5930 classification.

^{*** 3} samples to be tested for each horizon and results should be entered above for each horizon.

^{****} All signs of mottling should be recorded.

3.3(a) Percolation ("T") Test for Deep Subsoils and/or Water Table

Step 1: Test Hole Preparation

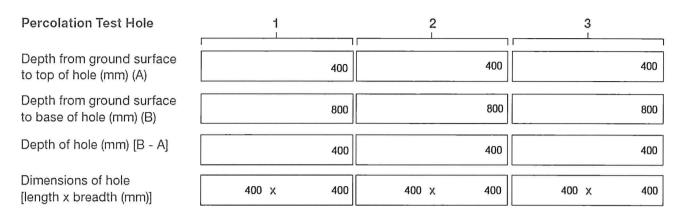

Step 2: Pre-Soaking Test Holes

Date and Time						
pre-soaking started	25/04/2019	08:36	25/04/2019	09:04	25/04/2019	09:12

Each hole should be pre-soaked twice before the test is carried out. Each hole should be empty before refilling.

Step 3: Measuring T₁₀₀

Percolation Test Hole No.	1	2	3
Date of test	26/04/2019	26/04/2019	26/04/2019
Time filled to 400 mm	09:14	09:19	09:27
Time water level at 300 mm	10:46	11:01	11:38
Time to drop 100 mm (T_{100})	92.00	102.00	131.00
Average T ₁₀₀			108.33

If $T_{100} > 300$ minutes then T-value >90 – site unsuitable for discharge to ground

If $T_{100} \le 210$ minutes then go to Step 4;

If $T_{100} > 210$ minutes then go to Step 5;

Step 4: Standard Method (where $T_{100} \le 210$ minutes)

Percolation Test Hole		1			2			3	
Fill no.	Start Time (at 300 mm)	Finish Tìme (at 200 mm)	∆t (min)	Start Time (at 300 mm)	Finish Time (at 200 mm)	Δt (min)	Start Time (at 300 mm)	Finish Time (at 200 mm)	Δt (min)
1	10:52	12:51	119.00	11:06	13:27	141.00	11:42	14:24	162.00
2	12:56	15:48	172.00	13:32	16:48	196.00	14:27	18:02	215.00
3 Average ∆t Value	15:52	20:06	254.00 181.67	16:53	21:31	278.00	18:07	23:09	302.00
	Average ∆t [Hole No.1]		45.42 (t ₁)	Average ∆t [Hole No.2]		51.25 (t ₂)	Average ∆ta [Hole No.3]		56.58 (t ₃)
Result of Tes	st: T =		51.08 (m	in/25 mm)					

Comments:

The T- Test passed with a T value of T = 51.08mins/25mm. From TABLE C3 of CoP this result is within the range for the soil type experienced at the invert level of where the T Test was carried, i.e. in Horizon C which is a SILT/CLAY where a range of 15-43mins/25mm is stated in TABLE C3 of CoP.


Step 5: Modified Method (where $T_{100} > 210$ minutes)

Percolation Test Hole No.		1				2				3		
Fall of water in hole (mm)	Time Factor = T,	Time of fall (mins) = T _m	K _{fs} = T _r / T _m	T – Value = 4.45 / K _{fs}	Time Factor = T,	Time of fall (mins) = T _m	K _{ts} = T _t / T _m	T – Value = 4.45 / K _{fs}	Time Factor = T _r	Time of fall (mins) = T _m	K _{ts} = T, / T _m	T – Value = 4.45 / K _{fs}
300 - 250	8.1				8.1				8.1			
250 - 200	9.7				9.7				9.7			
200 - 150	11.9				11.9				11.9			
150 - 100	14.1				14.1				14.1			
Average T- Value	T- Value	Hole 1=	= (t ₁)	0.00	T- Value	Hole 1=	(t ₂)	0.00	T- Value	Hole 1=	= (t ₃)	0.00

Result of Test: T =	0	.00 (min/25 mm)		
Comments:				

3.3(b) Percolation ("P") Test for Shallow Soil / Subsoils and/or Water Table

Step 1: Test Hole Preparation

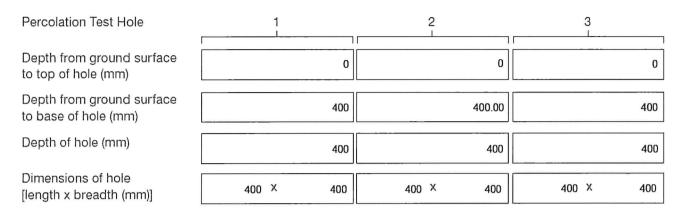

Step 2: Pre-Soaking Test Holes

Date and Time 25/04/2019 09:48 25/04/2019 25/04/2019 09:57 09:52 pre-soaking started

Each hole should be pre-soaked twice before the test is carried out. Each hole should be empty before refilling.

Step 3: Measuring P₁₀₀

Percolation Test Hole No.	1	2	3
Date of test	26/04/2019	26/04/2019	26/04/2019
Time filled to 400 mm	10:12	10:17	10:25
Time water level at 300 mm	11:01	11:22	11:41
Time to drop 100 mm (P ₁₀₀)	49.00	65.00	76.00
Average P ₁₀₀			63.33

If $P_{100} > 300$ minutes then T-value >90 – site unsuitable for discharge to ground

If $P_{100} \le 210$ minutes then go to Step 4; If $P_{100} > 210$ minutes then go to Step 5;

Step 4: Standard Method (where $P_{100} \le 210$ minutes)

Percolation Test Hole		1			2			3	
Fill no.	Start Time	Finish Time	∆p (min)	Start Time	Finish Time	∆p (min)	Start Time	Finish Time	Δp (min)
	(at 300 mm)	(at 200 mm)		(at 300 mm)	(at 200 mm)		(at 300 mm)	(at 200 mm)	
1	11:05	12:11	66.00	11:26	12:44	78.00	11:46	13:18	92.00
2	12:14	13:48	94.00	12:49	14:31	102.00	13:23	15:28	125.00
3	13:52	16:13	141.00	14:36	17:09	153.00	15:32	18:23	171.00
Average ∆p Value			100.33			111.00			129.33
	Average ∆p [Hole No.1]		25.08 (p ₁)	Average Δ		27.75 (p ₂)	Average Δ [Hole No.3		32.33 (p ₃)
D 11 (T			20.20 / :	/or \					

Result of Test: P = 28.39 (min/25 mm)

Comments:

The P- Test passed with a P value of P = 28.39mins/25mm. From TABLE C3 of CoP this result is within the range for the soil type experienced at the invert level of where the P Test was carried, i.e. in Horizon B which is a SILT/CLAY where a range of 15-43mins/25mm is stated in TABLE C3 of CoP.

Step 5: Modified Method (where $P_{100} > 210$ minutes)

Percolation Test Hole No.		1				2				3		
Fall of water in hole (mm)	Time Factor = T ₁	Time of fall (mins) = T _m	K _{fs} = T _f / T _m	P – Value = 4.45 / K _{fs}	Time Factor = T,	Time of fall (mins) = T _m	K _{f5} = T _f / T _m	P – Value = 4.45 / K _{fs}	Time Factor = T,	Time of fall (mins) = T _m	K _{f5} = T _f / T _m	P – Value = 4.45 / K _{rs}
300 - 250	8.1				8.1				8.1			
250 - 200	9.7				9.7				9.7			
200 - 150	11.9				11.9				11.9			
150 - 100	14.1				14.1				14.1			
Average P- Value	P- Value	e Hole 1:	= (p ₁)	0.00	 P- Value	Hole 1=	= (p ₂)	0.00	P- Value	e Hole 1:	= (p ₃)	0.00

Result of Test: P =	0.00 (min/25 mm)	
Comments:		

3.4 The following associated Maps, Drawings and Photographs should be appended to this site characterisation form.

- Discovery Series 1:50,000 Map indicating overall drainage, groundwater flow direction and housing density in the area.
- 2. Supporting maps for vulnerability, aquifer classification, soil, bedrock.
- 3. North point should always be included.
- 4. (a) Sketch of site showing measurements to Trial Hole location and
 - (b) Percolation Test Hole locations,
 - (c) wells and
 - (d) direction of groundwater flow (if known),
 - (e) proposed house (incl. distances from boundaries)
 - (f) adjacent houses,
 - (g) watercourses,
 - (h) significant sites
 - (i) and other relevant features.
- Cross sectional drawing of the site and the proposed layout¹ should be submitted.
- 6. Photographs of the trial hole, text holes and site (date and time referenced).

¹ The calculated percolation area or polishing filter area should be set out accurately on the site layout drawing in accordance with the code of practice's requirements.




Wells, Karst & Source Protection

Groundwater Wells and Springs Legend

Groundwater Wells and Springs

X SE

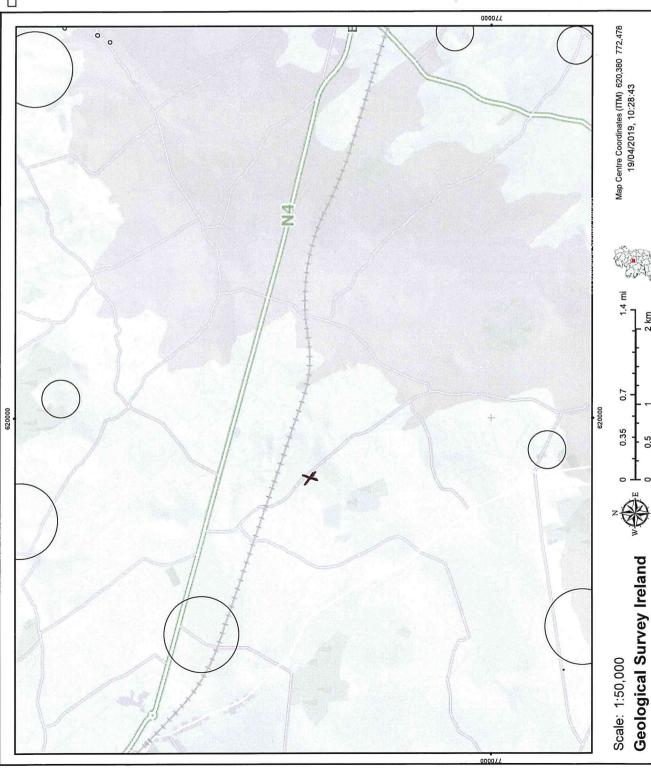

19/04/2019, 10:28:43


Ordnance Survey Ireland Licence No. EN 0047217 © Ordnance Survey Ireland/Government of Ireland © Geological Survey Ireland/Government of Ireland

This map and its data may not be used or reproduced for commercial purposes without the prior written permission of Copyright holders. This map is a user generated static output from an Internet mapping site and is for general reference only.

Data layers that appear on this map may or may not be accurate, current, or otherwise reliable.



Vulnerability

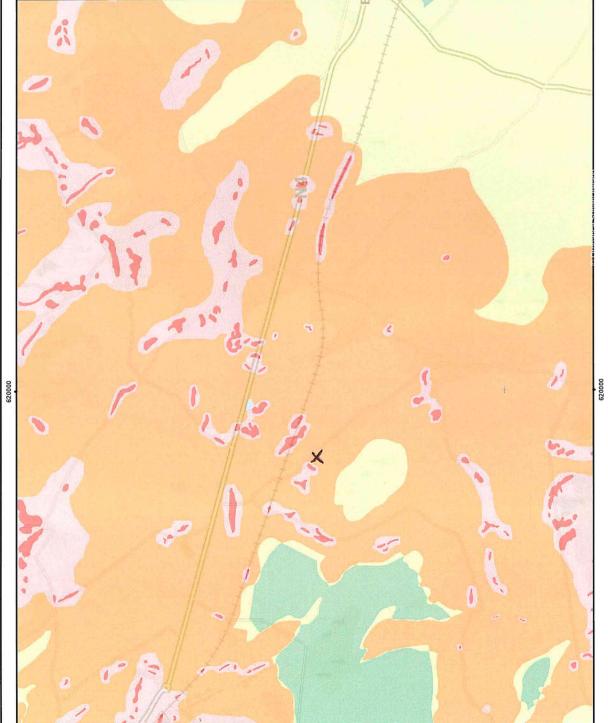

Legend

Groundwater Vulnerability

X - Rock at or near surface or Karst

E - Extreme

H - High

M - Moderate

L - Low

Map Centre Coordinates (ITM) 620,380 772,640 19/04/2019, 10:45:56

000044

2 km

0.35

Ordnance Survey Ireland Licence No. EN 0047217 © Ordnance Survey Ireland/Government of Ireland © Geological Survey Ireland/Government of Ireland

This map and its data may not be used or reproduced for commercial purposes without the prior written permission of Copyright holders. This map is a user generated static output from an Internet mapping site and is for general reference only.


Data layers that appear on this map may or may not be accurate, current, or otherwise reliable.

Geological Survey Ireland

Scale: 1:50,000





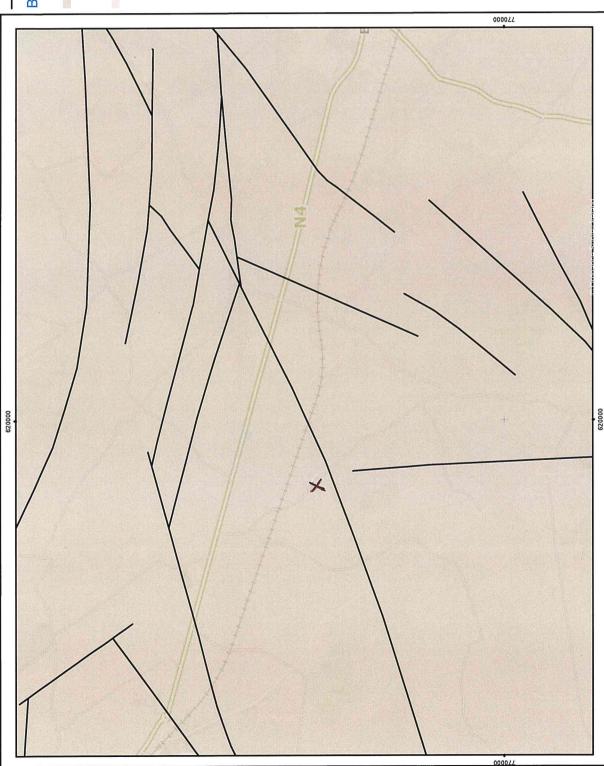

Legend

Bedrock Aquifer Faults

--- Bedrock Aquifer Faults

Bedrock Aquifer

LI - Locally Important Aquifer - Bedrock which is Moderately Productive only in

Local Zones

PI - Poor Aquifer - Bedrock which is Generally Unproductive except for Local Zones

x > S.E.

Geological Survey Ireland ()

Scale: 1:50,000

This map and its data may not be used or reproduced for commercial purposes without the prior written permission of Copyright holders. This map is a user generated static output from an Internet mapping site and is for general reference only.

Data layers that appear on this map may or may not be accurate, current, or otherwise reliable.

Ordnance Survey Ireland Licence No. EN 0047217 © Ordnance Survey Ireland/Government of Ireland © Geological Survey Ireland/Government of Ireland


Map Centre Coordinates (ITM) 620,380 772,640 19/04/2019, 10:55:25

0.7

0.35



Bedrock

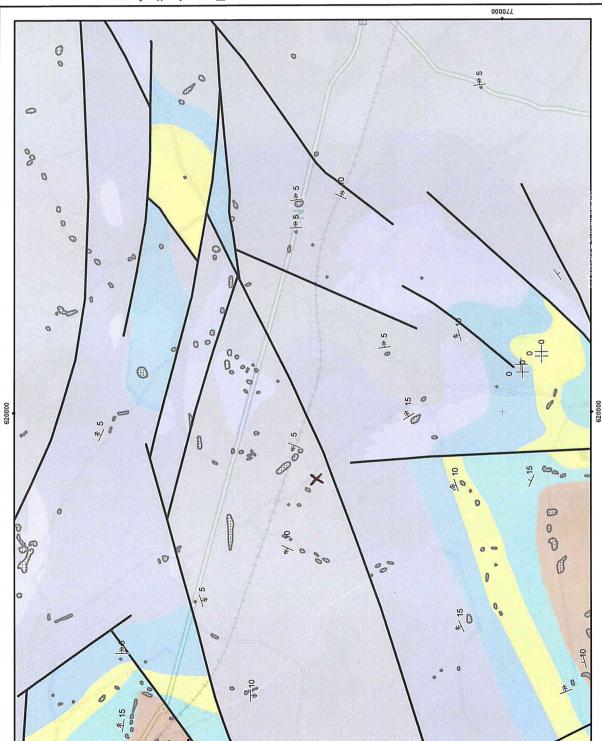

_egend

Bedrock Structural Symbols

- $_{\rm el}$ Dip of bedding or main foliation, old GSI data
- + Horizontal Bedding
- | Strike and dip of bedding, way up unknown

Bedrock Stratigraphic and Structural lines

- Fault
- -- Unconformity, dots on younger side
- X-Section

Bedrock Outcrop

- Bedrock Outcrop
- Bedrock Rock Units
- Meath Formation
- Moathill Formation
- Basal Clastics (Rinn Point Limestone Formation)
- **Ballysteen Formation**
- Lucan Formation
- Argillaceous Limestones
- Waulsortian Limestones
 - Mudbank Limestone
- Carrickateane Formation

Geological Survey Ireland

Scale: 1:50,000

This map and its data may not be used or reproduced for commercial purposes without the prior written permission of Copyright holders. This map is a user generated static output from an Internet mapping site and is for general reference only. Data lavers that appear on this map may or may not be accurate, current, or otherwise reliable.

1.4 mi 0.7 0.35


Ordnance Survey Ireland Licence No. EN 0047217
© Ordnance Survey Ireland/Government of Ireland
© Geological Survey Ireland/Government of Ireland

Map Centre Coordinates (ITM) 620,380 772,640

19/04/2019, 11:02:23



Subsoil

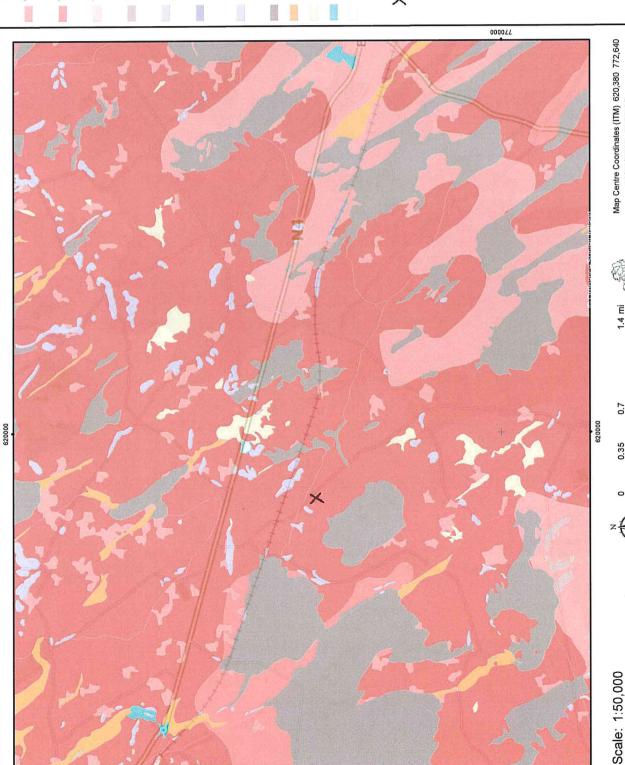

Legend

AminDW - Deep well drained mineral (Mainly acidic)

AminPD - Mineral poorly drained (Mainly acidic) AminPDPT - Peaty poorly drained mineral (Mainly acidic)

AminSW - Shallow well drained mineral (Mainly acidic)

BminSW - Shallow well drained mineral (Mainly basic) AminSP - Shallow poorly drained mineral (Mainly acidic)

BminSP - Shallow poorly drained mineral (Mainly basic)

BminSRPT - Shallow, rocky, peaty/non-peatymineral complexes (Mainly basic)

Cut - Cutover/cutaway peat

AlluvMIN - Alluvial (mineral)

Lac - Lacustrine type soils

Made - Made ground Water - Water

This map and its data may not be used or reproduced for commercial purposes without the prior written permission of Copyright holders. This map is a user generated static output from an Internet mapping site and is for general reference only. Data layers that appear on this map may or may not be accurate, current, or otherwise reliable.

Geological Survey Ireland

Ordnance Survey Ireland Licence No. EN 0047217 © Ordnance Survey Ireland/Government of Ireland © Geological Survey Ireland/Government of Ireland

19/04/2019, 11:00:15




















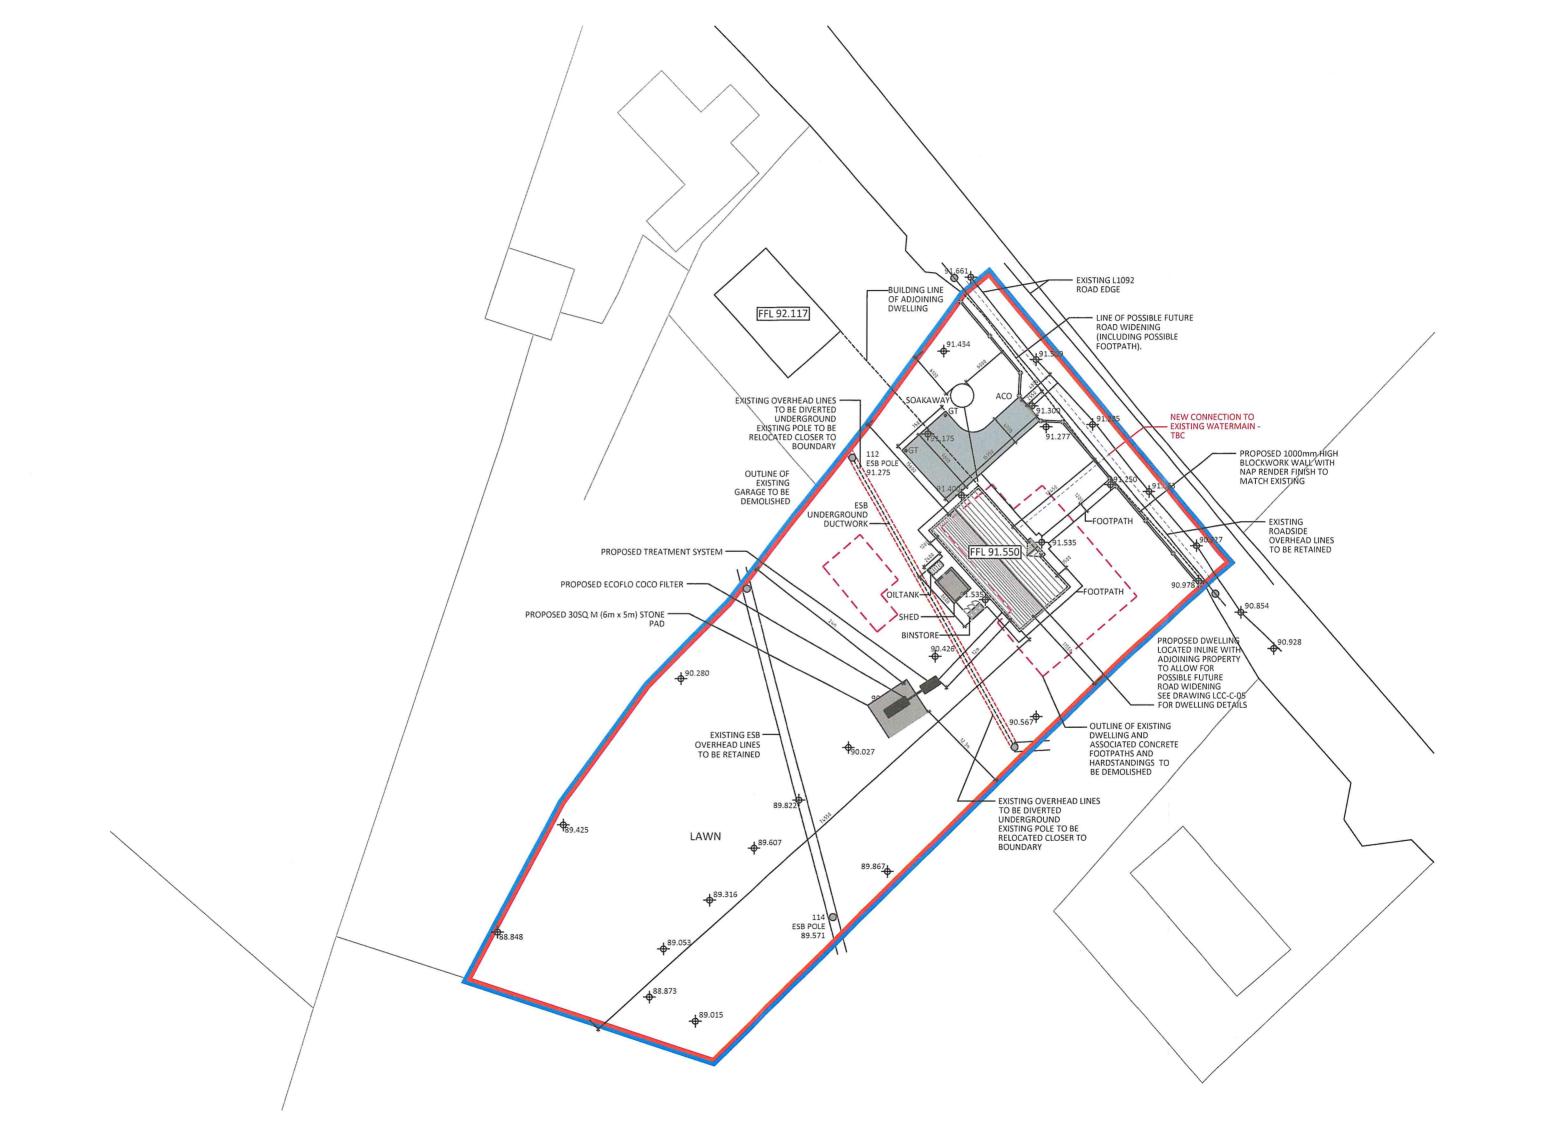

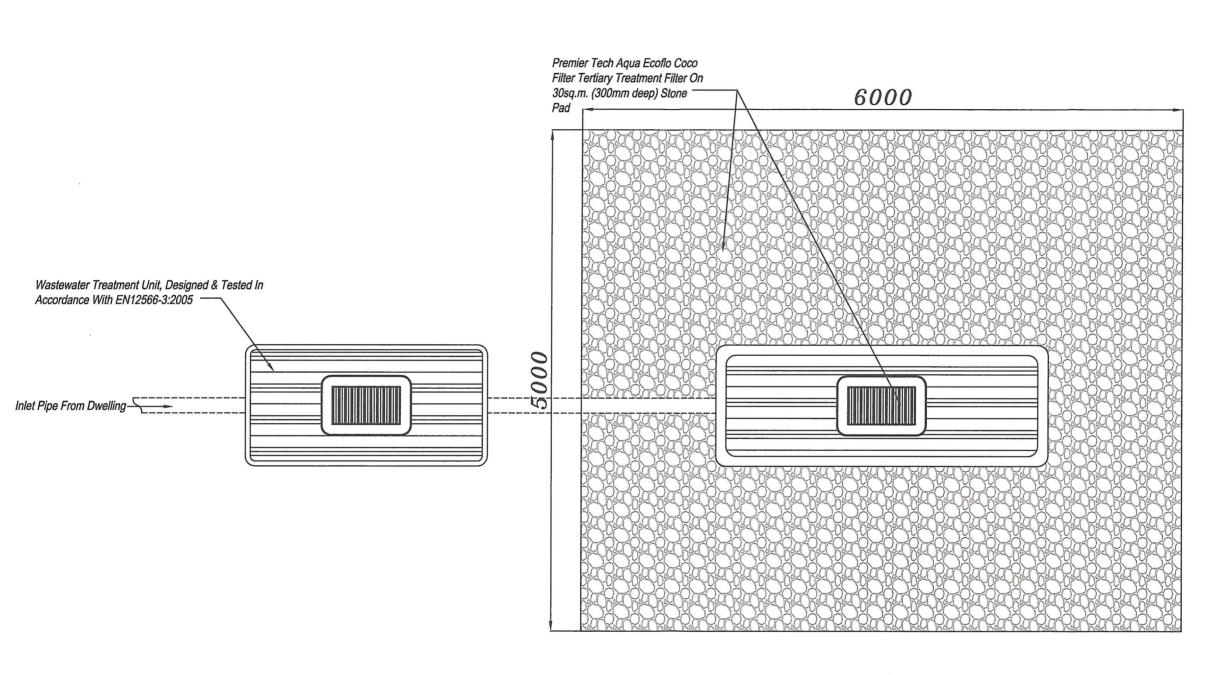

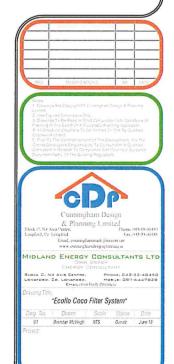

4.0 CONCLUSION of SITE CHARACTERISATION

Integrate the information from the desk study and on-site assessment (i.e. visual assessment, trial hole and percolation tests) above and conclude the type of system(s) that is (are) appropriate. This information is also used to choose the optimum final disposal route of the treated wastewater.

Not Suitable for Development		
Suitable for ¹ 1. Septic tank system (septic tank and percolation area)	No	Discharge Route Discharge to Ground Water
2. Secondary Treatment System		
 a. septic tank and filter system constructed on-site and polishing filter; or 	Yes	
b. packaged wastewater treatment system and polishing filter	Yes	
5.0 RECOMMENDATION		
Propose to install: Packaged wastewater treatment system and polishing for	ilter	
and discharge to: Ground Water		
Trench Invert level (m): SEE AMACHO	N Di	rawisgs
Site Specific Conditions (e.g. special works, site improvement works	testing etc	:.
After 48hrs there was no water table level evident in the 2.1m deep trial hole. The T T the T-Value is higher than 50mins/25mm it is therefore proposed to install a wastewal top of a stone pad as shown on the attached drawings. The average & highest P Test Value was 28.39 & 32.33mins/25mm respectively. From Section 7 & 9 of the CoP which was issued in August 2013 the Design Population Equations and the color of the CoP which was issued in August 2013 the Design Population Equations and the color of the coP which was issued in August 2013 the Design Population Equations and the color of the coP which was issued in August 2013 the Design Population Equations and the color of the coP which was issued in August 2013 the Design Population Equations and the color of the coP which was issued in August 2013 the Design Population Equations and the color of the coP which was issued in August 2013 the Design Population Equations and the color of the coP which was issued in August 2013 the Design Population Equations and the color of the coP which was issued in August 2013 the Design Population Equations and the color of the coP which was issued in August 2013 the Design Population Equations and the color of the coP which was issued in August 2013 the Design Population Equations and the color of the coP which was issued in August 2013 the Design Population Equations and the color of th	er treatment so the Clarifical Livalent for a 4	ystem with Ecoflo Coco Filter placed on ition to the design capacity requirements in bedroom house is 6 P.E. The size of the

¹ note: more than one option may be suitable for a site and this should be recorded

² A discharge of sewage effluent to "waters" (definition includes any or any part of any river, stream, lake, canal, reservoir, aquifer, pond, watercourse or other inland waters, whether natural or artificial) will require a licence under the Water Pollution Acts 1977-90. Refer to Section 2.6.2.

6.0 TREATMENT SYSTEM DETAILS SYSTEM TYPE: Septic Tank System Tank Capacity (m3) Percolation Area Mounded Percolation Area No. of Trenches No. of Trenches Length of Trenches (m) Length of Trenches (m) Invert Level (m) Invert Level (m) SYSTEM TYPE: Secondary Treatment System Filter Systems Package Treatment Systems Media Type Area (m2)* Depth of Filter Invert Level Type Mechanical Aeration unit Sand/Soil 6.00 Soil Capacity PE Constructed Wetland Sizing of Primary Compartment Other 3.00 m^3 SYSTEM TYPE: Tertiary Treatment System Polishing Filter: Surface Area (m2)* 30.00 Package Treatment System: Capacity (pe) or Gravity Fed: Constructed Wetland: Surface Area (m2)* No. of Trenches Length of Trenches (m) Invert Level (m) **DISCHARGE ROUTE:** Groundwater Hydraulic Loading Rate * (I/m².d) Surface Water ** Discharge Rate (m³/hr) TREATMENT STANDARDS: NΗ₃ Treatment System Performance Standard (mg/l) BOD SS Total N Total P 20.00 30.00 20.00 QUALITY ASSURANCE: Installation & Commissioning On-going Maintenance Installation supervised Cunningham Design & Planning Limited,

Block C, N4 Axis Centre, Longford. Commissioning Certificate issued

5 Year Maintenance Agreement in place between system supplier and house owner prior to occupation of the dwelling. Regular inspections of treatment system in accordance with Section G.3 of CoP. Percolation Area should be inspected at 6 monthly intervals in accordance with SECTION G.1.3 of CoP.

by supplier prior to occupation of the dwelling.

^{*} Hydrolic loading rate is determined by the percolation rate of subsoil

^{**} Water Pollution Act discharge licence required

7.0 SITE ASSESSOR DETAILS

Signature:

Company: Cunningham Design & Planning Ltd		
Prefix: Mr. First Name: Mark	Surname:	Cunningham
Address: Block C, N4 Axis Centre, Longford, Co. Longford		
2000.0,		
O 110 11 15 15 15 15 15 15 15 15 15 15 15 15		
Qualifications/Experience: BEng, MSc, CEng, MIEI		
Date of Report: 26/04/2019		
Phone: 043-3340450 Fax:	e-mail	mark@cunninghamdp.ie
Indemnity Insurance Number: See attached Professional Indemnity Insurance Number:	surance Certifica	ite.
indefinity insurance reamber.	Jaraneo Coranea	



SCHEDULE

Policy Number:

19-PI-SMU.01191

1) Insured:

Red Cow Design and Planning Ltd t/a Cunningham Design and Planning

Ltd

Principal Address:

Block C

N4 Axis Centre Longford Co. Longford

2) Business Description:

Consulting Engineers

3) Period of insurance:

From: 6th February 2019

Γο: 5th February 2020

Both days inclusive, local standard time, at the address of the Insured

4) Limit of Indemnity:

EUR2,000,000 Any One Claim, Costs & Expenses in Addition

5) Excess:

EUR3,000 Each and Every Claim

6) Premium:

EUR5,462.50

Plus 5% LEVY:

EUR 273.13

Total Premium:

EUR5,735.63

7) Area of Activities:

UK; ROI: C.Isles; IOM: EU

8) Jurisdiction:

UK; ROI: C.Isles; IOM; EU

9) Retroactive Date:

31st October 2012

10) Proposal Form Dated:

9th January 2019

11) Declaration Dated:

None

12) Conditions: Policy Terms and Conditions plus

Endorsement No: 1 - Premium Payment Warranty

13) Claims Notifications to:

Square Mile Underwriting

6 Lloyd's Avenue

London EC3N 3AX

claims@smu.uk.com Telephone: 020 7265 7490 Fax: 020 7265 7491



Chartered Engineer CEng MIEI

This is to certify that

Mark Cunningham

has been enrolled on the Institution's Register with the right to use the title

Chartered Engineer CEng MIEI

Regin Moran

President

John for

Danie ann

Membership Director and Registrar

18th June 2014

Date

The Institution of Engineers of Ireland

Gumann na nInnealtóirí

Established 1835, incorporated by Royal Charter 1877 and amended by the Institution of Givil Engineers of Ireland (Charter Amendment) Acts 1960 and 1969.

The Institution promotes the art and science of engineering and the interests of that profession in all its specialist disciplines.



This is to certify

Mark Cunningham

Has Quecessfully Completed H

Septic Tank Maintenance @ Repair Training Course

With


Chevran Training

19th - 23rd February 2013



Mr. John Conway MBA - Managing Director Chevron Training & Development 17D.

FRAINING TOMORROWS SKILLS TODAY -

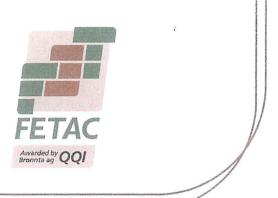

Teastas Comhpháirte Component Certificate

Bronnta ar Awarded to

Mark Cunningham

Level 6 Building Energy Rating Assessment

Distinction

16/12/2013

F0512463 38003R

Padra Wat



Chief Executive/Príomhfheidhmeannach QQI

Awarded by Quality and Qualifications Ireland (QQI) under Section 84 of the Qualifications and Quality Assurance (Education and Training) Act 2012

Bronnta an Dearbhú Cáilíochta agus Cáilíochtaí Éireann (QQI) faoi Alt 84 d'Acht na oCáilíochtaí agus Dhearbhú Cáilíochta (Qideachas agus Qiliúint) 2012

HOUSING SECTION

Town Hall, Market Square, Longford.

Tel: +353 (0)43 3343300 Email: info@longfordcoco.ie

	T		1	1	_			_							-						_
PROJECT No.			Day	19		<u> </u>				_										_	
1.00/0	PLANNING		Month	07		<u> </u>				_										4	_
LCC/C			Year	19																4	_
			Issued By	dw	'																_
Drawing no.		Scale	Size			1	1				- 1		-	-	-	-	-	-	-		_
	Site:				<u> </u>					_								_		4	_
LCC/C/01	Site Location	1:2500	A3	#	<u> </u>					_								_		4	_
LCC/C/02	Existing Site Layout	1:500	A3	#	_	<u> </u>			_	_										+	_
LCC/C/03	Proposed Site & Services Layout	1:500	A3	#	-	<u> </u>			_		-							_		+	_
	Dwelling:				-					+	-					-		-	-	+	
LCC/C/05	Floor Plan & Elevations	1:100	A3	#						-								_		+	_
LCC/C/06	Elevations & Section A-A	1:100	A3	#	1					-										+	_
200/0/00	Liovationic & Coolion 777	1.100	7.0	"						1								1		\top	-
										T								-		\top	_
																				T	_
																					_
																				T	_
																				T	
																				_	
										_										+	
					_					_										_	_
					_	<u> </u>			_	_										+	_
					_				_	_										+	_
					_				_	_										+	_
				+						_								_		-+	_
				+						_								_		-+	_
				+						-								_		+	_
				+						-								_		+	_
				+						-								=		\dashv	_
					<u> </u>					1	-				1		-	- †	+	-	_
										1								1		\top	-
																				T	_
										T										T	_
																					_
									;	# =	Iss	ue	d I	Lett	er =	= Di	raw	ing	Re۱	visio	on
DISTRIBUTIO																					_
Longford Cou	nty Council - Planning Part 8			Р																	
Department o	f Housing Planning and Local Government																				
																				_	
				1	<u> </u>	<u> </u>	\sqcup	_	_	4	_					_	_		_	+	
				\vdash	<u> </u>	<u> </u>	$\vdash \vdash$	_	_	-					_	_	}		+	+	_
				+	1	 	H	_	+	+	\dashv					-	_	+	+	+	
				1	1	 		-	+	\dashv	\dashv				-		-	\dashv	\dashv	+	
				1			H		1	1	\dashv					7	T	$\neg \dagger$	1	十	_
				1						1	T								1	\top	_
				Ī							T						T		T	T	
- LCC File																					_

STATUS

= Preliminary AC = Approval/Comments IN = Information P = Planning FC = Fire Certificate T = Tender C = Construction R = Requested

HOUSING SECTION

Town Hall, Market Square, Longford.

Tel: +353 (0)43 3343300 Email: info@longfordcoco.ie

	T		1	1	_			_							-						_
PROJECT No.			Day	19		<u> </u>				_										_	
1.00/0	PLANNING		Month	07						_										4	_
LCC/C			Year	19																4	_
			Issued By	dw	'																_
Drawing no.		Scale	Size			1	1				- 1		-	-	-	-	-	-			_
	Site:				<u> </u>					_								_		4	_
LCC/C/01	Site Location	1:2500	A3	#	<u> </u>					_								_		4	_
LCC/C/02	Existing Site Layout	1:500	A3	#	_	<u> </u>			_	_										+	_
LCC/C/03	Proposed Site & Services Layout	1:500	A3	#	-	<u> </u>			_		-							_		+	_
	Dwelling:				-					+	-					-		-	-	+	
LCC/C/05	Floor Plan & Elevations	1:100	A3	#						-								_		+	_
LCC/C/06	Elevations & Section A-A	1:100	A3	#	1					-										+	_
200/0/00	Liovationic & Coolion 777	1.100	7.0	"						1								1		\top	-
										T								-		\top	_
																				T	_
																					_
																				T	_
																				T	
																				_	
										_										+	
					_					_										_	_
					_	<u> </u>			_	_										+	_
					_	<u> </u>			_	_										+	_
					_	<u> </u>			_	_										+	_
				+						_								_		-+	_
				+						_								_		-+	_
				+						-								_		+	_
				+						-								_		+	_
				+						-								=		\dashv	_
					<u> </u>					1	-				1		-	- †	+	-	_
										1								1		\top	-
																				T	_
										T										T	_
																					_
									;	# =	Iss	ue	d I	Lett	er =	= Di	raw	ing	Re۱	visio	on
DISTRIBUTIO																					_
Longford Cou	nty Council - Planning Part 8			Р																	
Department o	f Housing Planning and Local Government																				
																				_	
				1	<u> </u>	<u> </u>	\sqcup	_	_	4	_					_	_		_	+	
				\vdash	<u> </u>	<u> </u>	$\vdash \vdash$	_	_	-					_	_	}		+	+	_
				+	1	 	H	_	+	+	\dashv					-	_	+	+	+	
				1	1	 		-	+	+	\dashv				-		-	\dashv	\dashv	+	
				1			H		1	7	\dashv					7	T	$\neg \dagger$	1	十	_
				1						1	T								1	\top	_
				Ī							T						T		T	T	
- LCC File																					_

STATUS

= Preliminary AC = Approval/Comments IN = Information P = Planning FC = Fire Certificate T = Tender C = Construction R = Requested

HOUSING SECTION

Town Hall, Market Square, Longford.

Tel: +353 (0)43 3343300 Email: info@longfordcoco.ie

	T		1	1	_			_							-					_	_
PROJECT No.			Day	19		<u> </u>				_										_	
1.00/0	PLANNING		Month	07						_										4	_
LCC/C			Year	19																4	_
			Issued By	dw	'																_
Drawing no.		Scale	Size			1	1				- 1		-	-	-	-	-	-	-		_
	Site:				<u> </u>					_								_		4	_
LCC/C/01	Site Location	1:2500	A3	#	<u> </u>					_								_		4	_
LCC/C/02	Existing Site Layout	1:500	A3	#	_				_	_										+	_
LCC/C/03	Proposed Site & Services Layout	1:500	A3	#	-	<u> </u>			_		-							_		+	_
	Dwelling:				-					+	-					-			-	+	
LCC/C/05	Floor Plan & Elevations	1:100	A3	#						-								_		+	_
LCC/C/06	Elevations & Section A-A	1:100	A3	#	1					-										+	_
200/0/00	Liovationic & Coolion 777	1.100	7.0	"						1								1		\top	-
										T								-		\top	_
																				T	_
																					_
																				T	_
																				T	
																				_	
										_										+	
					_					_										_	_
					_	<u> </u>			_	_										+	_
					_				_	_										+	_
					_				_	_										+	_
				+						_								_		-+	_
				+						_								_		-+	_
				+						-								_		+	_
				+						-								_		+	_
				+						-								=		\dashv	_
					<u> </u>					1	-				1		-	- †	+	-	_
										1								1		\top	-
																				T	_
										T										T	_
																					_
									;	# =	Iss	ue	d I	Lett	er =	= Di	raw	ing	Re۱	visio	on
DISTRIBUTIO																					_
Longford Cou	nty Council - Planning Part 8			Р																	
Department o	f Housing Planning and Local Government																				
																				_	
				1	<u> </u>	<u> </u>	\sqcup	_	_	4	_					_	_		_	+	
				\vdash	<u> </u>	<u> </u>	$\vdash \vdash$	_	_						_	_	}		+	+	_
				+	1	 	H	_	+	+	\dashv					-	_	+	\dashv	+	
				1	1	 		-	+	+	\dashv						-	\dashv	\dashv	+	
				1			H		1	7	\dashv					7	T	$\neg \dagger$	1	十	_
				1						1	T								1	\top	_
				Ī							T						T		T	T	
- LCC File																					_

STATUS

= Preliminary AC = Approval/Comments IN = Information P = Planning FC = Fire Certificate T = Tender C = Construction R = Requested

HOUSING SECTION

Town Hall, Market Square, Longford.

Tel: +353 (0)43 3343300 Email: info@longfordcoco.ie

	T		1	1	_			_							-					_	_
PROJECT No.			Day	19		<u> </u>				_										_	
1.00/0	PLANNING		Month	07						_										4	_
LCC/C			Year	19																4	_
			Issued By	dw	'																_
Drawing no.		Scale	Size			1	1				- 1		-	-	-	-	-	-	-		_
	Site:				<u> </u>					_								_		4	_
LCC/C/01	Site Location	1:2500	A3	#	<u> </u>					_								_		4	_
LCC/C/02	Existing Site Layout	1:500	A3	#	_	<u> </u>			_	_										+	_
LCC/C/03	Proposed Site & Services Layout	1:500	A3	#	-	<u> </u>			_		-							_		+	_
	Dwelling:				-					+	-					-		-	-	+	
LCC/C/05	Floor Plan & Elevations	1:100	A3	#						-								_		+	_
LCC/C/06	Elevations & Section A-A	1:100	A3	#	1					-										+	_
200/0/00	Liovationic & Coolion 777	1.100	7.0	"						1								1		\top	-
										T								-		\top	_
																				T	_
																					_
																				T	_
																				T	
																				_	
										_										+	
					_					_										_	_
					_	<u> </u>			_	_										+	_
					_	<u> </u>			_	_										+	_
					_	<u> </u>			_	_										+	_
				+						_								_		-+	_
				+						_								_		-+	_
				+						-								_		+	_
				+						-								_		+	_
				+						-								=		\dashv	_
					 					1	-				1		-	- †	+	-	_
										1								1		\top	-
																				T	_
										T										T	_
																					_
									;	# =	Iss	ue	d I	Lett	er =	= Di	raw	ing	Re۱	visio	on
DISTRIBUTIO																					_
Longford Cou	nty Council - Planning Part 8			Р																	
Department o	f Housing Planning and Local Government																				
																				_	
				1	<u> </u>	<u> </u>	\sqcup	_	_	4	_					_	_		_	+	
				\vdash	1	<u> </u>	$\vdash \vdash$	_	_	-					_	_	}		+	+	_
				+	1	 	H	_	+	+	\dashv					-	_	+	+	+	
				1	1	 		-	+	+	\dashv				-		-	\dashv	\dashv	+	
				1			H		1	7	\dashv					7	T	$\neg \dagger$	1	十	_
				1						1	T								1	\top	_
				Ī							T						T		T	T	
- LCC File																					_

STATUS

= Preliminary AC = Approval/Comments IN = Information P = Planning FC = Fire Certificate T = Tender C = Construction R = Requested

HOUSING SECTION

Town Hall, Market Square, Longford.

Tel: +353 (0)43 3343300 Email: info@longfordcoco.ie

	T		1	1	_			_							-					_	_
PROJECT No.			Day	19		<u> </u>				_										_	
1.00/0	PLANNING		Month	07		<u> </u>				_										4	_
LCC/C			Year	19																4	_
			Issued By	dw	'																_
Drawing no.		Scale	Size			1	1				- 1		-	-	-	-	-	-			_
	Site:				<u> </u>					_								_		4	_
LCC/C/01	Site Location	1:2500	A3	#	<u> </u>					_								_		4	_
LCC/C/02	Existing Site Layout	1:500	A3	#	_	<u> </u>			_	_										+	_
LCC/C/03	Proposed Site & Services Layout	1:500	A3	#	-	<u> </u>			_		-							_		+	_
	Dwelling:				-					+	-					-		-	-	+	
LCC/C/05	Floor Plan & Elevations	1:100	A3	#						-								_		+	_
LCC/C/06	Elevations & Section A-A	1:100	A3	#	1					-										+	_
200/0/00	Liovationic & Coolion 777	1.100	7.0	"						1								1		\top	-
										T								-		\top	_
																				T	_
																					_
																				T	_
																				T	
																				_	
										_										+	
					_					_										_	_
					_	<u> </u>			_	_										+	_
					_	<u> </u>			_	_										+	_
					_	<u> </u>			_	_										+	_
				+						_								_		-+	_
				+						_								_		-+	_
				+						-								_		+	_
				+						-								_		+	_
				+						-								=		\dashv	_
					 					1	-				1		-	- †	+	-	_
										1								1		\top	-
																				T	_
										T										T	_
																					_
									;	# =	Iss	ue	d I	Lett	er =	= Di	raw	ing	Re۱	visio	on
DISTRIBUTIO																					_
Longford Cou	nty Council - Planning Part 8			Р																	
Department o	f Housing Planning and Local Government																				
																				_	
				1	<u> </u>	<u> </u>	\sqcup	_	_	4	_					_	_		_	+	
				\vdash	1	<u> </u>	$\vdash \vdash$	_	_	-					_	_	}		+	+	_
				+	\vdash	 	H	_	+	+	\dashv					-	_	+	+	+	
				1	1	 		-	+	\dashv	\dashv						-	\dashv	\dashv	+	
				1			H		1	7	\dashv					7	T	$\neg \dagger$	1	十	_
				1						1	T								1	\top	_
				Ī							T						T		T	T	
- LCC File																					_

STATUS

= Preliminary AC = Approval/Comments IN = Information P = Planning FC = Fire Certificate T = Tender C = Construction R = Requested

HOUSING SECTION

Town Hall, Market Square, Longford.

Tel: +353 (0)43 3343300 Email: info@longfordcoco.ie

	T		1	1	_			_							-						_
PROJECT No.			Day	19		<u> </u>				_										_	
1.00/0	PLANNING		Month	07						_										4	_
LCC/C			Year	19																4	_
			Issued By	dw	'																_
Drawing no.		Scale	Size			1	1				- 1		-	-	-	-	-	-	-		_
	Site:				<u> </u>					_								_		4	_
LCC/C/01	Site Location	1:2500	A3	#	<u> </u>					_								_		4	_
LCC/C/02	Existing Site Layout	1:500	A3	#	_	<u> </u>			_	_										+	_
LCC/C/03	Proposed Site & Services Layout	1:500	A3	#	-	<u> </u>			_		-							_		+	_
	Dwelling:				-					+	-					-		-	-	+	
LCC/C/05	Floor Plan & Elevations	1:100	A3	#						-								_		+	_
LCC/C/06	Elevations & Section A-A	1:100	A3	#	1					-										+	_
200/0/00	Liovationic & Coolion 777	1.100	7.0	"						1								1		\top	-
										T								-		\top	_
																				T	_
																					_
																				T	_
																				T	
																				_	
										_										+	
					_					_										_	_
					_	<u> </u>			_	_										+	_
					_	<u> </u>			_	_										+	_
					_	<u> </u>			_	_										+	_
				+						_								_		-+	_
				+						_								_		-+	_
				+						-								_		+	_
				+						-								_		+	_
				+						-								=		\dashv	_
					<u> </u>					1	-				1		-	- †	+	-	_
										1								1		\top	-
																				T	_
										T										T	_
																					_
									;	# =	Iss	ue	d I	Lett	er =	= Di	raw	ing	Re۱	visio	on
DISTRIBUTIO																					_
Longford Cou	nty Council - Planning Part 8			Р																	
Department o	f Housing Planning and Local Government																				
																				_	
				1	<u> </u>	<u> </u>	\sqcup	_	_	4	_					_	_		_	+	
				\vdash	<u> </u>	<u> </u>	$\vdash \vdash$	_	_	-					_	_	}		+	+	_
				+	\vdash	 	H	_	+	+	\dashv					-	_	+	\dashv	+	
				1	1	 		-	+	\dashv	\dashv						-	\dashv	\dashv	+	
				1			H		1	1	\dashv					7	T	$\neg \dagger$	1	十	_
				1						1	T								1	\top	_
				Ī							T						T		T	T	
- LCC File																					_

STATUS

= Preliminary AC = Approval/Comments IN = Information P = Planning FC = Fire Certificate T = Tender C = Construction R = Requested

HOUSING SECTION

Town Hall, Market Square, Longford.

Tel: +353 (0)43 3343300 Email: info@longfordcoco.ie

	T		1	1	_			_							-						_
PROJECT No.			Day	19		<u> </u>				_										_	
1.00/0	PLANNING		Month	07		<u> </u>				_										4	_
LCC/C			Year	19																4	_
			Issued By	dw	'																_
Drawing no.		Scale	Size			1	1				- 1		-	-	-	-	-	-	-		_
	Site:				<u> </u>					_								_		4	_
LCC/C/01	Site Location	1:2500	A3	#	<u> </u>					_								_		4	_
LCC/C/02	Existing Site Layout	1:500	A3	#	_	<u> </u>			_	_										+	_
LCC/C/03	Proposed Site & Services Layout	1:500	A3	#	-	<u> </u>			_		-							_		+	_
	Dwelling:				-					+	-					-			-	+	
LCC/C/05	Floor Plan & Elevations	1:100	A3	#						-								_		+	_
LCC/C/06	Elevations & Section A-A	1:100	A3	#	1					-										+	_
200/0/00	Liovationic & Coolion 777	1.100	7.0	"						1								1		\top	-
										T								-		\top	_
																				T	_
																					_
																				T	_
																				T	
																				_	
										_										+	
					_					_										_	_
					_	<u> </u>			_	_										+	_
					_	<u> </u>			_	_										+	_
					_	<u> </u>			_	_										+	_
				+						_								_		-+	_
				+						_								_		-+	_
				+						-								_		+	_
				+						-								_		+	_
				+						-								=		\dashv	_
					<u> </u>					1	-				1	-	-	- †	+	-	_
										1								1		\top	-
																				T	_
										T										T	_
																					_
									;	# =	Iss	ue	d I	Lett	er =	= Di	raw	ing	Re۱	visio	on
DISTRIBUTIO																					_
Longford Cou	nty Council - Planning Part 8			Р																	
Department o	f Housing Planning and Local Government																				
																				_	
				1	<u> </u>	<u> </u>	\sqcup	_	_	4	_					_	_		_	+	
				\vdash	<u> </u>	<u> </u>	$\vdash \vdash$	_	_						_	_	}		+	+	_
				+	1	 	H	_	+	+	\dashv					-	_	+	+	+	
				1	1	 		-	+	\dashv	\dashv				-		-	\dashv	\dashv	+	
				1			H		1	1	\dashv					7	T	$\neg \dagger$	1	十	_
				1						1	T								1	\top	_
				Ī							T						T		T	T	
- LCC File																					_

STATUS

= Preliminary AC = Approval/Comments IN = Information P = Planning FC = Fire Certificate T = Tender C = Construction R = Requested

HOUSING SECTION

Town Hall, Market Square, Longford.

Tel: +353 (0)43 3343300 Email: info@longfordcoco.ie

	T		1	1	_			_							-						_
PROJECT No.			Day	19		<u> </u>				_										_	
1.00/0	PLANNING		Month	07		<u> </u>				_										4	_
LCC/C			Year	19																4	_
			Issued By	dw	'																_
Drawing no.		Scale	Size			1	1				- 1		-	-	-	-	-	-			_
	Site:				<u> </u>					_								_		4	_
LCC/C/01	Site Location	1:2500	A3	#	<u> </u>					_								_		4	_
LCC/C/02	Existing Site Layout	1:500	A3	#	_	<u> </u>			_	_										+	_
LCC/C/03	Proposed Site & Services Layout	1:500	A3	#	-	<u> </u>			_		-							_		+	_
	Dwelling:				-					+	-					-		-	-	+	
LCC/C/05	Floor Plan & Elevations	1:100	A3	#						-								_		+	_
LCC/C/06	Elevations & Section A-A	1:100	A3	#	1					-										+	_
200/0/00	Liovationic & Coolion 777	1.100	7.0	"						1								1		\top	-
										T								-		\top	_
																				T	_
																					_
																				T	_
																				T	
																				_	
										_										+	
					_					_										_	_
					_	<u> </u>			_	_										+	_
					_	<u> </u>			_	_										+	_
					_	<u> </u>			_	_										+	_
				+						_								_		-+	_
				+						_								_		-+	_
				+						-								_		+	_
				+						-								_		+	_
				+						-								=		\dashv	_
					<u> </u>					1	-				1	-	-	-	+	-	_
										1								1		\top	-
																				T	_
										T										T	_
																					_
									;	# =	Iss	ue	d I	Lett	er =	= Di	raw	ing	Re۱	visio	on
DISTRIBUTIO																					_
Longford Cou	nty Council - Planning Part 8			Р																	
Department o	f Housing Planning and Local Government																				
																				_	
				1	<u> </u>	<u> </u>	\sqcup	_	_	4	_					_	_		_	+	
				\vdash	<u> </u>	<u> </u>	$\vdash \vdash$	_	_	-					_	_	}		+	+	_
				+	1	 	H	_	+	+	\dashv					-	_	+	+	+	
				1	1	 		-	+	\dashv	\dashv				-		-	\dashv	\dashv	+	
				1			H		1	1	\dashv					7	T	$\neg \dagger$	1	十	_
				1						1	T								1	\top	_
				Ī							T						T		T	T	
- LCC File																					_

STATUS

= Preliminary AC = Approval/Comments IN = Information P = Planning FC = Fire Certificate T = Tender C = Construction R = Requested

HOUSING SECTION


Town Hall, Market Square, Longford.

Tel: +353 (0)43 3343300 Email: info@longfordcoco.ie


	T		1	1	_			_							-						_
PROJECT No.			Day	19		<u> </u>				_										_	
1.00/0	PLANNING		Month	07		<u> </u>				_										4	_
LCC/C			Year	19																4	_
			Issued By	dw	'																_
Drawing no.		Scale	Size			1	1				- 1		-	-	-	-	-	-			_
	Site:				<u> </u>					_								_		4	_
LCC/C/01	Site Location	1:2500	A3	#	<u> </u>					_								_		4	_
LCC/C/02	Existing Site Layout	1:500	A3	#	_				_	_										+	_
LCC/C/03	Proposed Site & Services Layout	1:500	A3	#	-	<u> </u>			_		-							_		+	_
	Dwelling:				-					+	-					-		-	-	+	
LCC/C/05	Floor Plan & Elevations	1:100	A3	#						-								_		+	_
LCC/C/06	Elevations & Section A-A	1:100	A3	#	1					-										+	_
200/0/00	Liovationic & Coolion 777	1.100	7.0	"						1								1		\top	-
										T								-		\top	_
																				T	_
																					_
																				T	_
																				T	
																				_	
										_										+	
					_					_										_	_
					_	<u> </u>			_	_										+	_
					_				_	_										+	_
					_				_	_										+	_
				+						_								_		-+	_
				+						_								_		-+	_
				+						-								_		+	_
				+						-								_		+	_
				+						-								=		\dashv	_
					 					1	-				1	-	-	- †	+	-	_
										1								1		\top	-
																				T	_
										T										T	_
																					_
									;	# =	Iss	ue	d I	Lett	er =	= Di	raw	ing	Re۱	visio	on
DISTRIBUTIO																					_
Longford Cou	nty Council - Planning Part 8			Р																	
Department o	f Housing Planning and Local Government																				
																				_	
				1	<u> </u>	<u> </u>	\sqcup	_	_	4	_					_	_		_	+	
				\vdash	1	<u> </u>	$\vdash \vdash$	_	_	-					_	_	}		+	+	_
				+	1	 	H	_	+	+	\dashv					-	_	+	+	+	
				1	1	 		_	+	\dashv	\dashv				-		-	\dashv	\dashv	+	
				1			H		1	7	\dashv					7	T	$\neg \dagger$	1	十	_
				1						1	T								1	\top	_
				Ī							T						T		T	T	
- LCC File																					_


STATUS


= Preliminary AC = Approval/Comments IN = Information P = Planning FC = Fire Certificate T = Tender C = Construction R = Requested

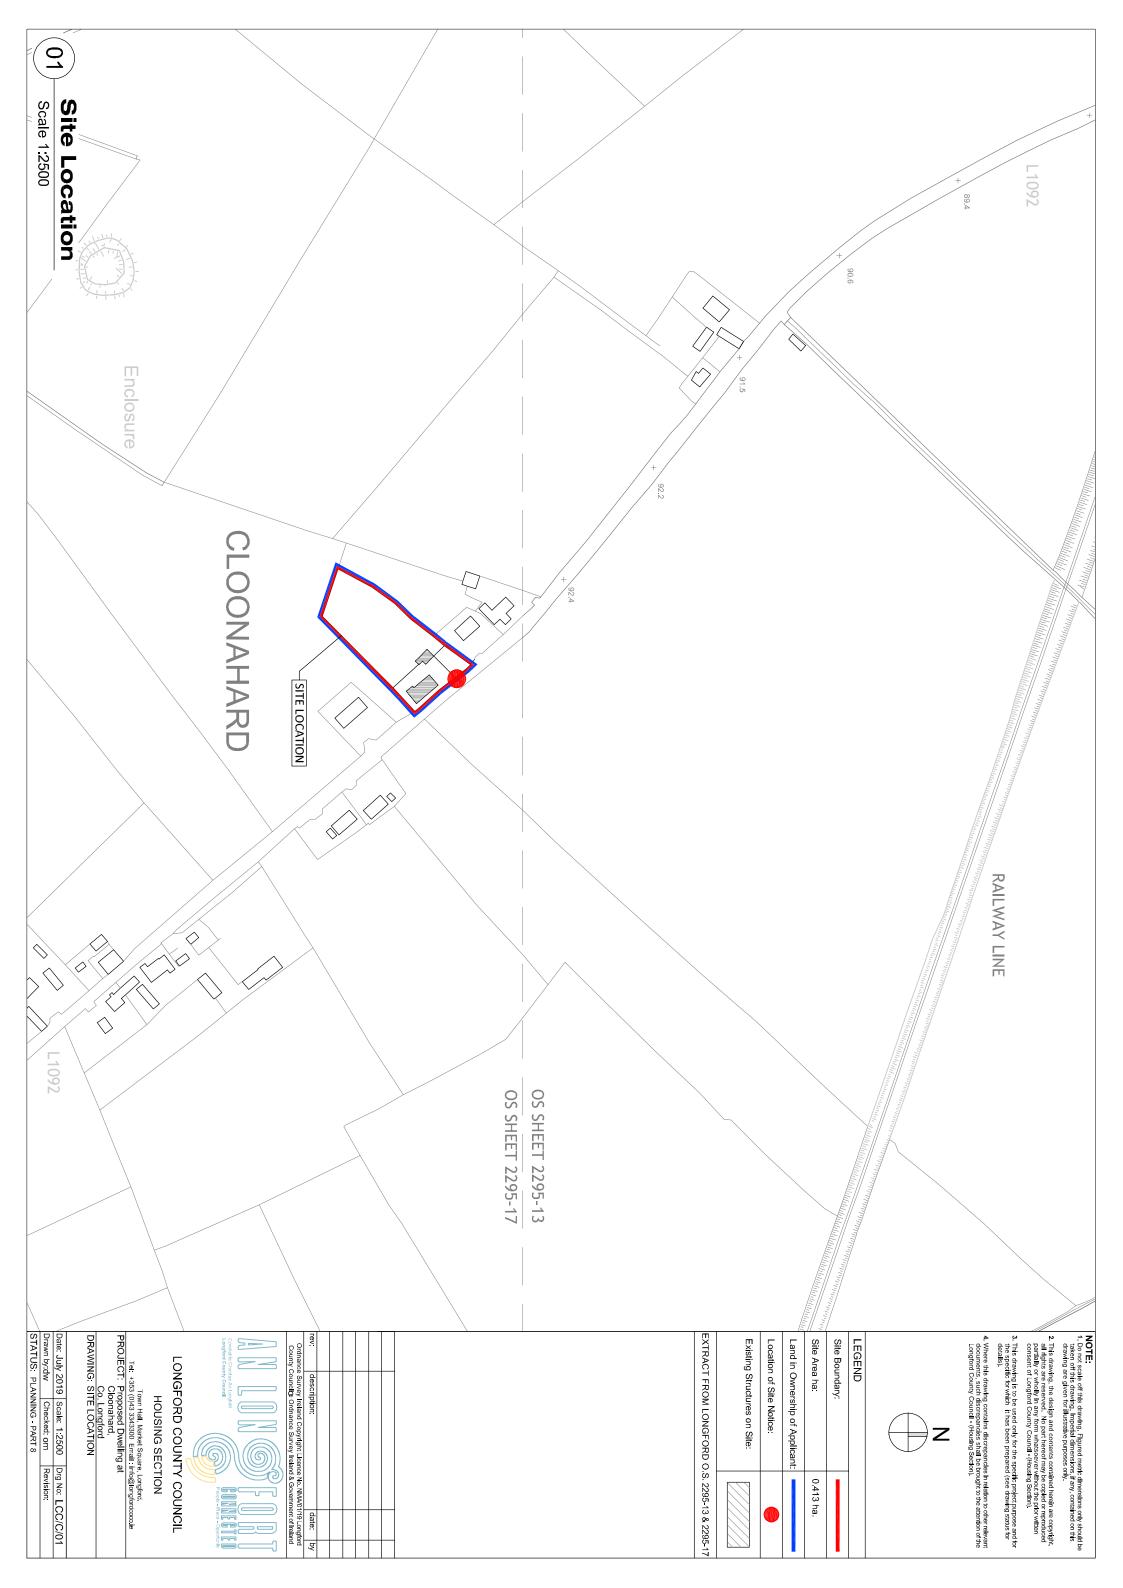



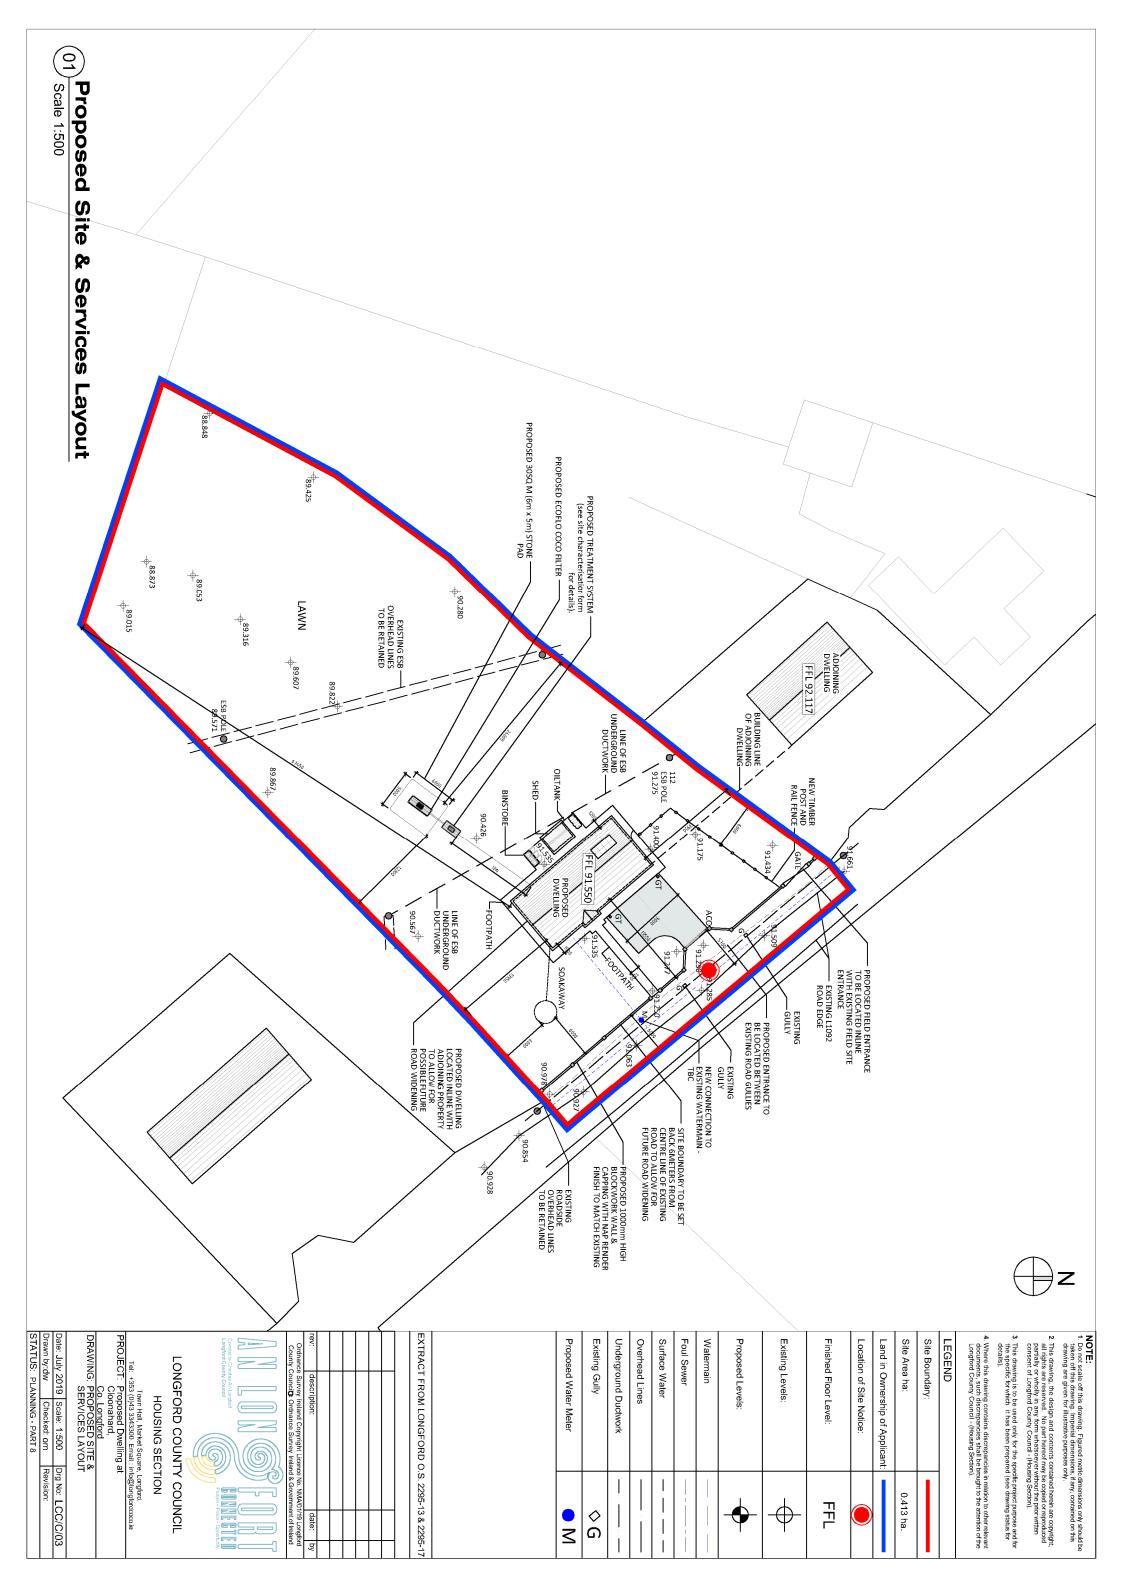

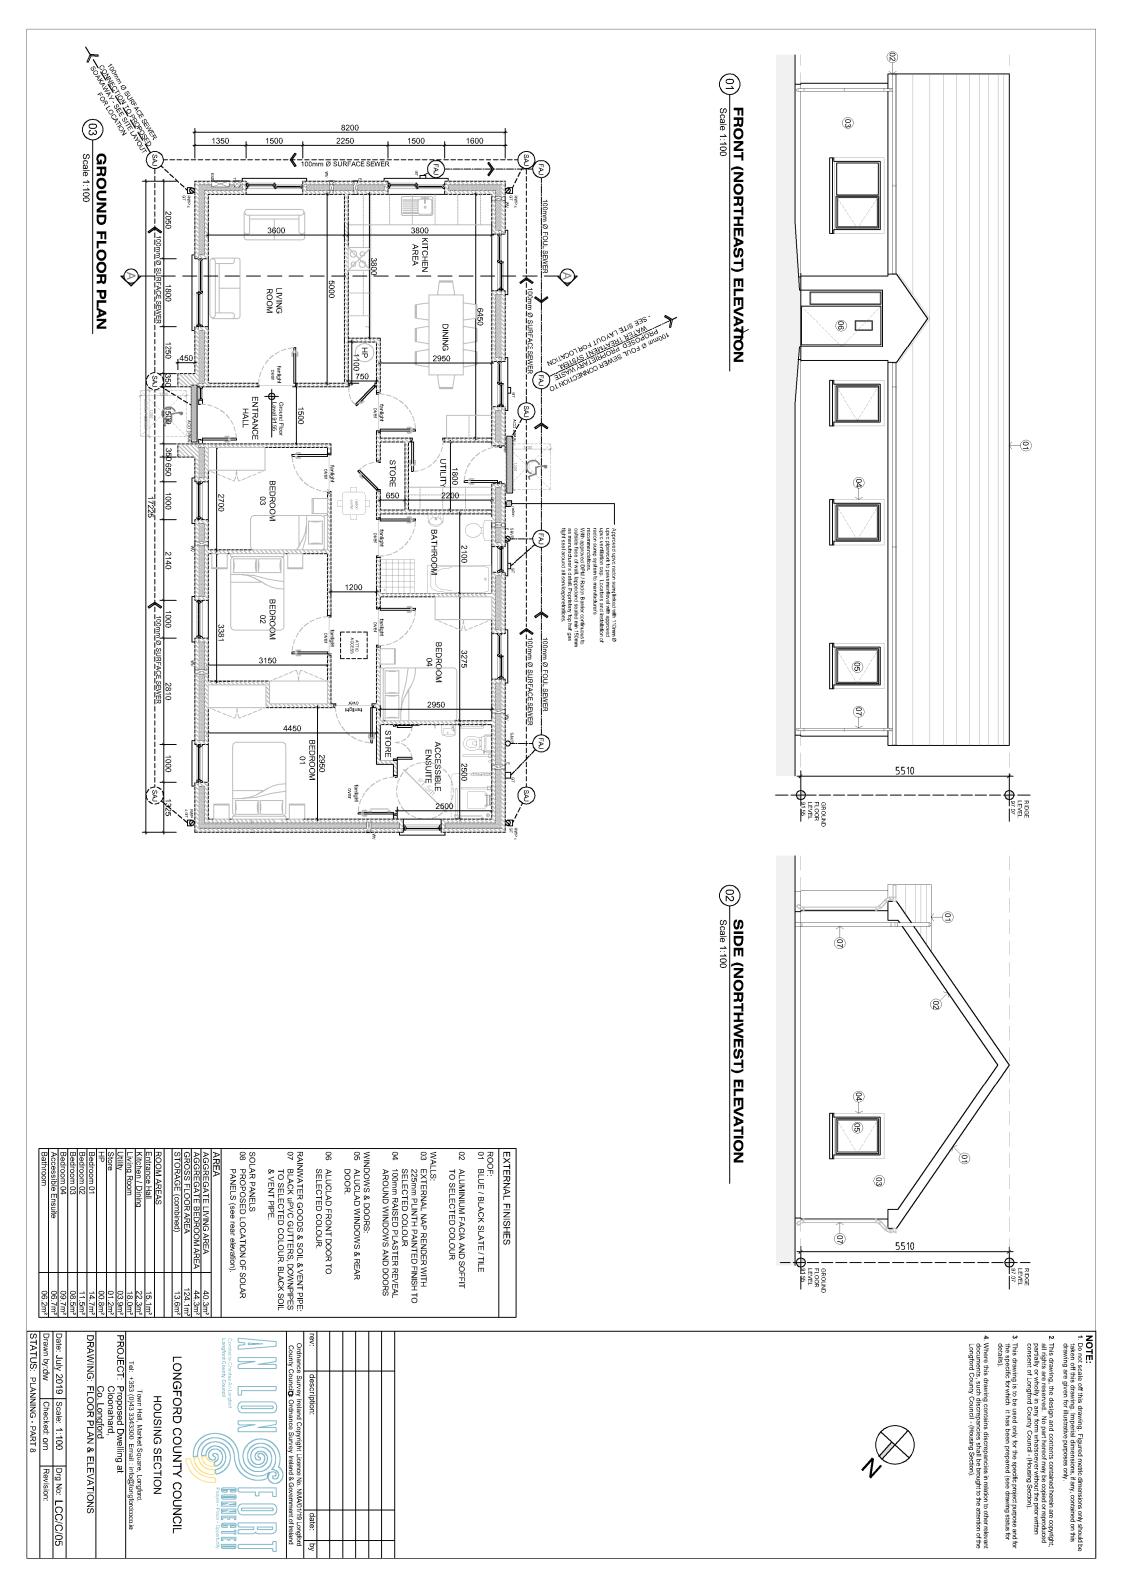

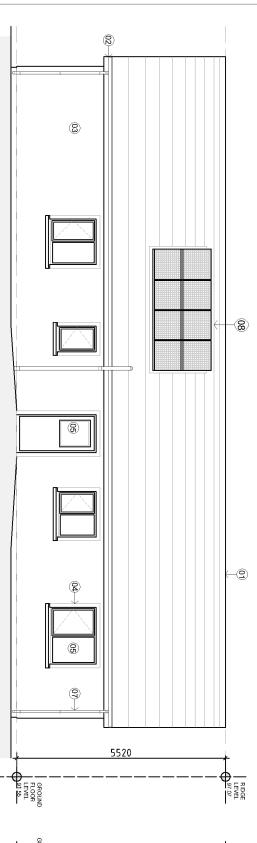

(3) (2) (8) 6 (23)

NOTE:

Do not scale off this drawing. Figured metric dimensions only should be taken off this drawing. Imperial dimensions, if any, contained on this drawing are given for illustrative purposes only.

. This drawing, the design and contents contained herein are copyright, all rights are reserved. No part hereof may be copied or reproduced partially or wholly in any form whatseever without the prior written consent of Longford County Council - (Housing Section).

This drawing is to be used only for the specific project purpose and for the specific for which it has been prepared (see drawing status for details).


REAR (NORTHWEST) ELEVATION

Scale 1:100

SIDE (SOUTHEAST) ELEVATION

Scale 1:100

(8)

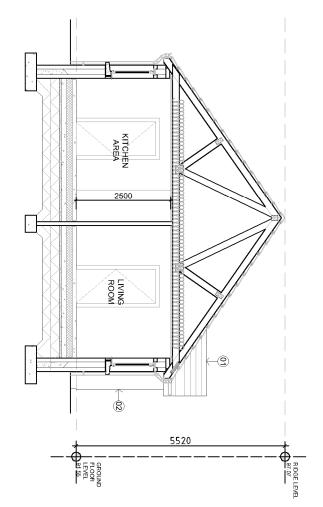

SECTION A - A
Scale 1:100

	04 100mm RAISED PLASTER REVEAL AROUND WINDOWS AND DOORS	TERNAL NAP RENDER WITH	WALLS:	02 ALUMINIUM FACIA AND SOFFIT TO SELECTED COLOUR		ROOF: 01 BLUE / BLACK SLATE / TILE	EXTERNAL FINISHES
SOLAR PANELS 08 PROPOSED LOCATION OF SOLAR PANELS	TO SELECTED COLOUR. BLACK SOIL & VENT PIPE.	RAINWATER GOODS & SOIL & VENT PIPE:	SELECTED COLOUR (front elevation).	06 ALUCLAD FRONT DOOR TO	DOOR.	WINDOWS & DOORS: 05 ALUCLAD WINDOWS & REAR	

PROPOSED CONSTRUCTION:

-oundations Construction: n-situ reinforced concrete strip for

oor Construction:

lab to engineer's detail on radon barrier continous to outside face of wall, lapped and sealed min 150mm as manufacturer's detail sealed min 150mm as manufacturer's detail. ibor slab to be 100mm cementitous screed with 25mm HD perimeter insulation up-stand in 150mm Kingspan Kooltherm K3 floor scale for similar approved on concrete insulation or similar approved on concrete insulation of similar approved in some concentration of similar approved in similar approv ice penetrations, on 50mm san 25mm layers of well compacted

Wall Construction: External Walls:

350mm cavity blockwork wall with external nap render finish (to select colour) on 100mm blockwork outer leaf with 150mm cavity with 140mm Kingspan Aerofullin Platinum® insulation or similar approved uter leaf and 100mm blockwork inner leaf vith plastered skim coat finish.

Roof Construction:
Roof pitch as shown with blue black o slate / roor tile with laps as per manufacturer's recommendation on nternal Walls: 100 / 215mm blockwork / 100mm timber stud partition with gypsum skim finish. with blue black colour

50 x 38mm treated slating battens confirm batten size with the slate manufactures

nstallation specification on solitex® plus pro clima) or similar approved breathable membrane fixed to roof trusses, membrane ith the manufactures installation guideling **All Ramps:**Constructed to a MAX slipe of 1 in 12

g clima) or similar approvel airtight membrane fixed to underside of ceiling joists fixing, lapping and tapping in accordance with the manufactures installationguidelines and specifications to be placed prior to fixing of 38 x 50mm service zonewith 12.5mm approved plasterboard ad skim finish. joists, to achieve max. uralue of 0.12w/m²k and a min. 30 minute fireresistance. All pipework to be insulated vith insulation wall thickness to match bore # pipe as per TGD d Part G with all joints covered and taped. All tanks to be insulated. Privide walkboard to be securely fixed. SeeM&E drawings and specification for location route of all services in the Attic spac. Intelio®plus (pro services in the Attic space. Intelio®plus (pro services in the Attic space.) Attic space:
300mm mineral fibre quil insulation, max.
k-value 0.035w/mk, between and over

External Joinery:

Black Aluclad windows aid rear door with front door to selected cobur. Bedroom windows should have anopenable section which provides an unobsructed clear open area of at least 0.33 m² with a min height of 450mm (i.e. possibly mir opening section of 450mm (w) x 750mm (h))

Rainwater Goods: uPVC black gutters and cownpipes

Access for Disabled:
all work and materials used to be in
accordance with latest addition
of the Building Regulations TGD Part M

Sanitary Conveniences:
A W.C. should be provided at entry level and it should be contained in a bathroom or separate W.C. compartment. A clear space 750mm x 1200mm, accessible by sideways transfer from weelchair to wc.

Date: July 2019 | Scale: 1:100

Drawn by:dw | Checked: om

STATUS: PLANNING - PART 8

Drg No:

Rainwater uPVC black

Access for Disabled:
All work and materials used to be in accordance with latest addition of the Building Regulations TGD Part M

d to a slope of 1 in 12

nci**©** Ordnan

Ventilation:

All habitable rooms to have background ventilation of not less than 6500mm², the opening for rapid ventilation should not be less than 1/20th of the floor area, the kitchen has a mechanical extract ventilation at a rate of 30 litres per second incorporated in the cooker hood, all bathrooms have mechanical extract ventilation of 15 litres per second.

Airtightness:

AB, NSAI, BBA certified airtight vapour check membrane, grommets and tapes to be used to be used to comply with TGD L 2011, Conservation of Fuel & Energy.

5=

9

LONGFORD COUNTY COUNCIL

9

HOUSING SECTION

Drainage:
100mm diameter upvc pipes to be laid in trenches and bedded in pea gravel at a minimum depth of 900mm under any road d and 600mm in lawn and garden areas.
See proposed site layout for location and runs.

Town Hall, Market Square, Longford.

+353 (0)43 3343300 Email : info@longfordoxxxie

T: Proposed Dwelling at
Cloonahard,

ELEVATIONS & SECTION A - A

The minimum clear opining width of door to be 775mm min. There should be a level area at least 1200mm² in front of such door. The access shall have a threshold height of 15mm max. The door threshold shall incorporate a drainage channel to discharge into a suitable guily trap. Door handles should be located at a height of 900mm to 1200mm above floor levels. Electric light switches and door bell (at entrance) should be installed at a similar height. Entrance Door:
The minimum clear o
be 775mm min. There

gutters and downpipes Goods:

All Ramps: Constructed to

4. Where this drawing contains discrepancies in relation to other relevant documents, such discrepancies shall be brought to the attention of the Longford County Council - (Housing Section).